

1-5/8" 12 GAUGE CHANNEL

OR 2" x 2" x 1/4" ANGLE

REDUCER, IF REQUIRED (TYP.)

TEMPERATURE

INDICATION TO ECC. SEE

CONTROL DIAGRAM (TYP.)

SIDE VIEW TRAPEZE HANGER FOR UP TO 1000 LB. UNIFORM LOAD

MAXIMUM PIPE/TUBING SUPPORT SPACING

SINGLE COIL

WHEN COIL IS INCLUDED IN CASING MOUNTED ON VIBRATION ISOLATORS THE FIRST TWO HANGERS FOR EACH PIPE SHALL BE SPRING & NEOPRENE TYPE. TYPE "H" 4" DIA. PIPE &

PIPING SHALL BE INSTALLED IN SUCH A MANNER THAT IT WILL NOT BLOCK THE SWING OR USE OF ACCESS DOORS OR PANELS; NEITHER SHALL IT BLOCK THE SERVICING OF FILTERS,

THE FLOW ELEMENT MAY BE INSTALLED IN THE SUPPLY PIPINGREQUIRED MINIMUM UPSTEAM AND DOWNSTREAM DIMENSIONS CANNOT BE OBTAINED IN THE RETURN PIPING.

NOTES: SEE SPECIFIER FOR DETAILED HANGER REQUIREMENTS

NOTE: FOR TRAPEZE HANGER TAKE SPACING OF SMALLEST SIZE ON TRAPEZE

PIPE HANGERS SHALL SUPPORT

WATER COIL

SMALLER. TYPE "H-P" FOR 5" DIA. PIPE & LARGER.

PIPING INDEPENDENT OF COIL (TYP.)

DRAIN WHEN COIL IS NOT _

SELF-DRAINING (TYP.)

VALVES, OR EQUIPMENT.


NOM. SIZE (IN.)


PIPE (FT.)


TUBING (FT.)

5 PIPE HANGER N.T.S.

AIR VENT WHEN COIL IS NOT SELF-VENTING (TYP.)

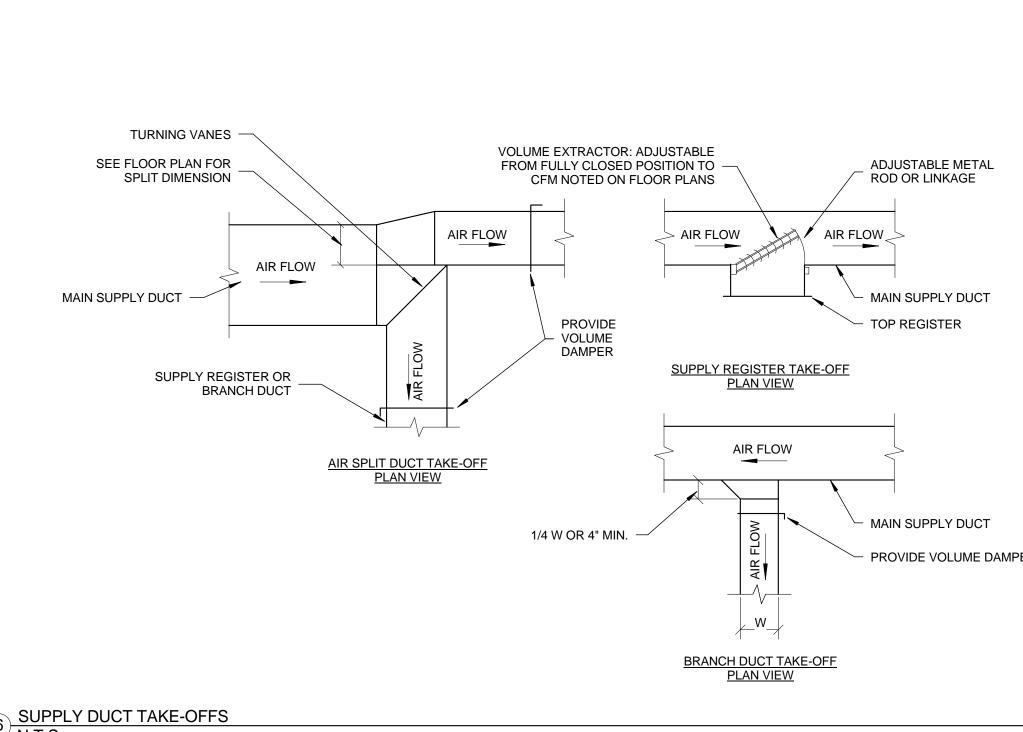

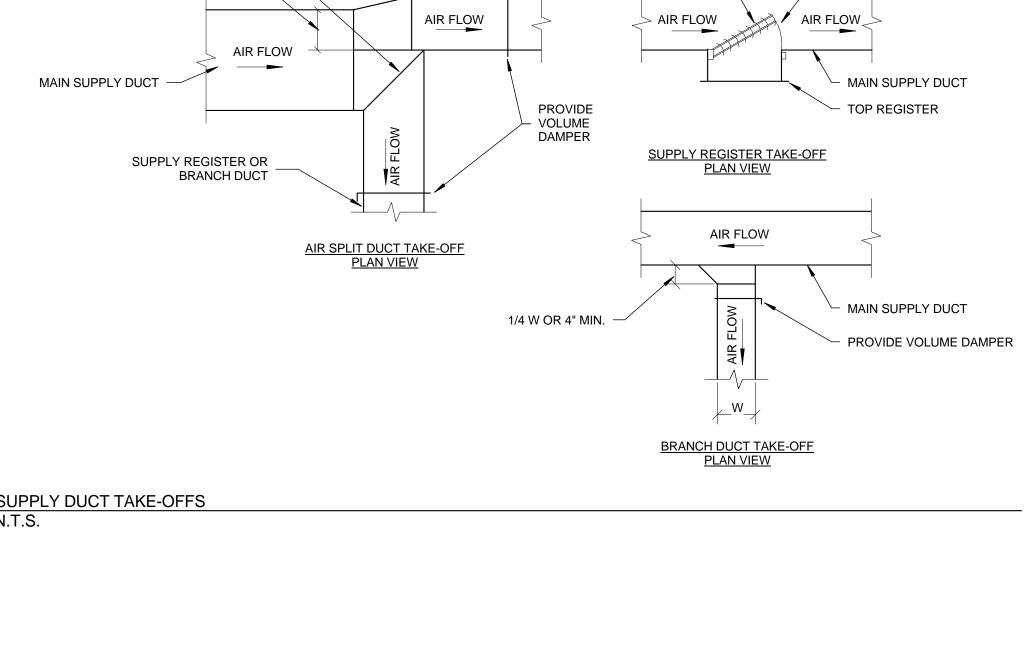


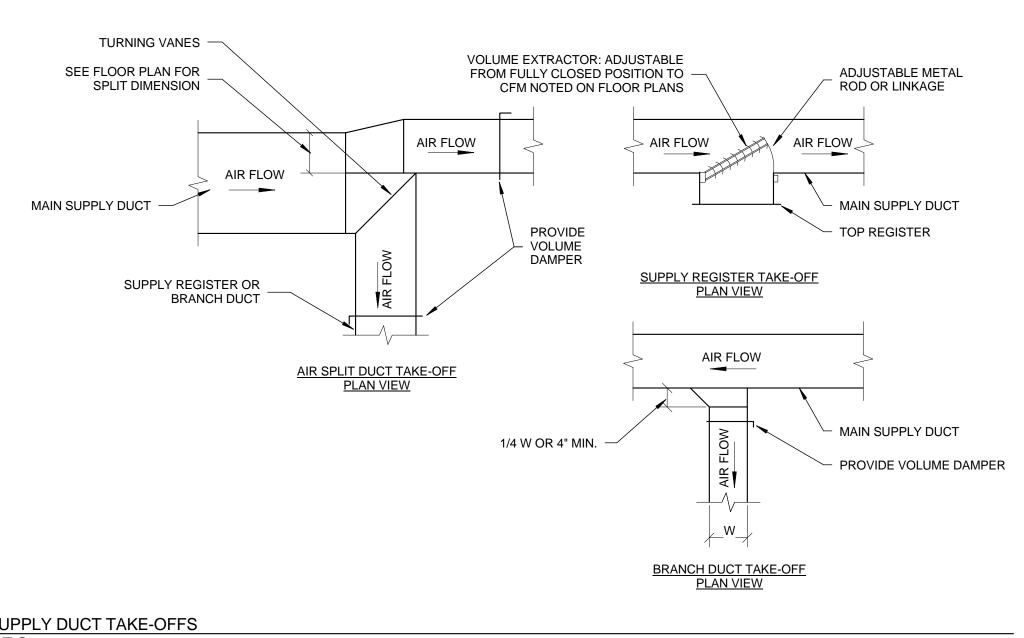

AIRFLOW

TYPICAL DUCTWORK TRANSITION WITH EQUIPMENT MOUNTED IN DUCT PLAN OR SIDE VIEW

NOTE: UNLESS OTHERWISE INDICATED ON PLANS, MAXIMUM ANGLES SHOWN SHALL APPLY.

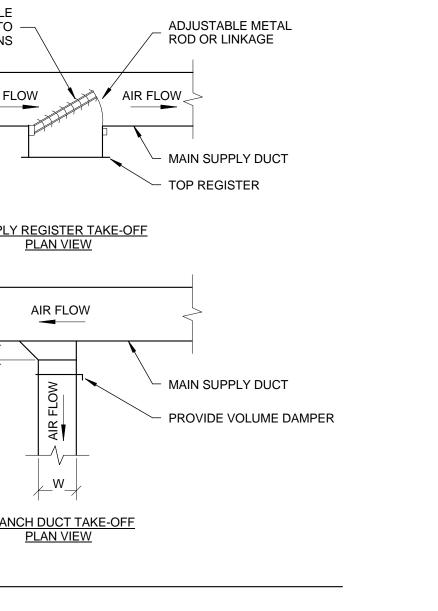


TYPICAL DUCTWORK TRANSITION
PLAN OR SIDE VIEW

STIFFEN BLADE

AS REQUIRED

SIDE ELEVATION

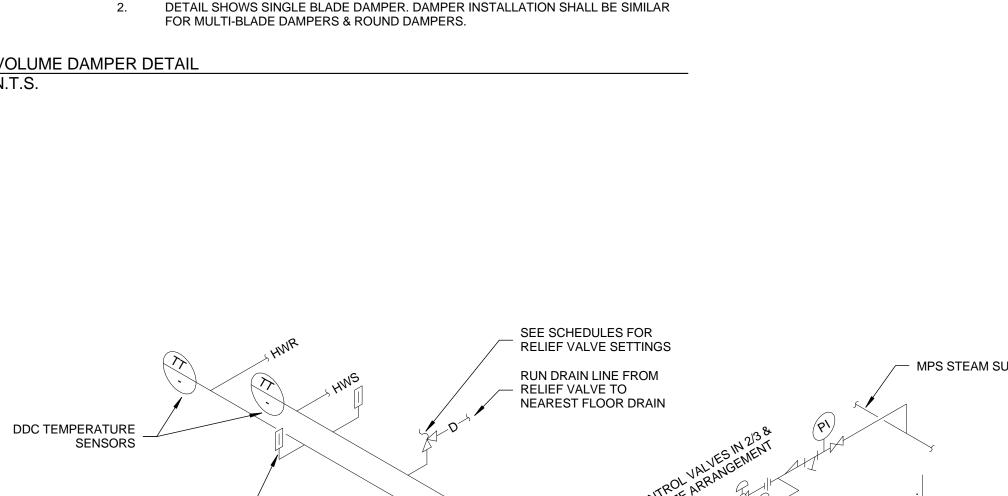

MAIN EXHAUST OR RETURN

BRANCH DUCT

INSULATION SEE SPECIFICATION

INSULATION

STAND-OFF

DAMPER BLADE

HANDLE WITH

LOCKING

QUADRANT

1/8" CLEARANCE ALL AROUND

INSIDE END BEARING

1. DELETE INSULATION STAND-OFF ON DUCTWORK WITHOUT EXTERIOR INSULATION.

- 1/4W OR 4" MIN.


PROVIDE VOLUME DAMPER

AT EACH BRANCH DUCT

─ 1/2" ROUND ROD PIN

<u>SECTION</u>

OUTSIDE END BEARING -

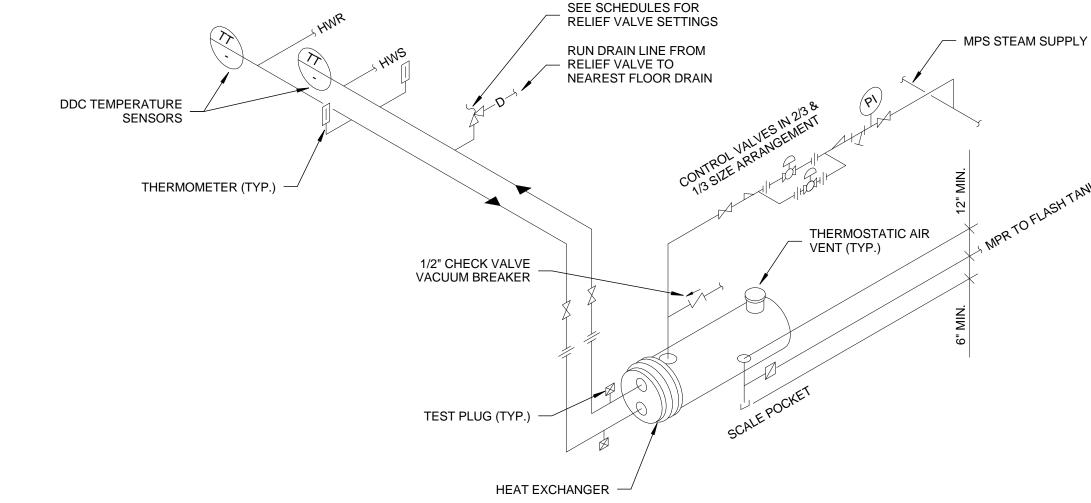

- 1. PROVIDE SADDLE SUPPORTS AND LEGS OR HANGERS FOR HEAT EXCHANGER. MOUNTING HEIGHT TO SHALL BE ADJUSTED TO FACILITATE GRAVITY RETURN OR STEAM CONDENSATE
- MAKE THE BYPASS THE SAME SIZE AS THE CONNECTIONS TO THE CONTROL VALVES.
- 3. CONTROL VALVES SHALL BE IN A 1/3 AND 2/3 SIZE ARRANGEMENT.

9 HEAT EXCHANGER - STEAM TO HOT WATER N.T.S.

PIPE HANGERS: PROVIDE DOUBLE DEFLECTION NEOPRENE (TYPE HN) FOR FIRST TWO ON EACH SIDE OF PUMP (SEE NOTE)	PRESSURE GAUGE
BALL OR BUTTERFLY VALVE (TYP.)	1/2" STRAINER FLEXIBLE CONNECTION (TYP.)

SUPPORT PUMP FROM PIPING ONLY. DO NOT SUPPORT PUMP FROM MOTOR.

NOTE:

10 INLINE PUMP CONNECTIONS N.T.S.

1. ALL VANE ELBOWS SHALL BE CONSTRUCTED AND INSTALLED AS DETAILED BY

4. WHEN W EQUAL W2 AND W1 IS GREATER THAN 20" VANES SHALL BE DOUBLE

WHEN W1 DOES NOT EQUAL W2, VANE SHALL BE SINGLE THICKNESS VANE TYPE REGARDLESS OF W DIMENSION.

ALL SINGLE THICKNESS VANES SHALL HAVE A 2" RADIUS, 1-1/2" MAXIMUM SPACE BETWEEN VANES AND A 3/4" TRAILING EDGE.

FULLY SPRINKLERED ISSUED FOR BID

8 WATER COILS - PIPING ON N.T.S.	PIPING CONNECTIONS 10 INLINE PUMP CONNECTIONS N.T.S.															155	UED FOR BID
	CONSULT	TANTS:								PROJECT MANAGER:	Project Number 3627	Scale N.T.S.	Drawing Title MECHANICAL DETAILS	Project Title RENOVA	TE BUILDING 69	VA Project Number 542-CSI-203	
	Project Manager BRAY MOONEY CONSULTING	Architect ARRAY HEALTHCARE FACILITIES	Structural Engineer WZG, STRUCTURAL CONSULTING	MEP/FP Engineer APOGEE CONSULTING	Civil Engineer GUIDON DESIGN	Fire Protection Consultant HARRINGTON GROUP	Cost Estimator BRAY MOONEY CONSULTING	Aquatic Consultant ATLANTIC AQUATIC	Associate Architects W. COOK ARCHITECTS	Bray						Building Number 69	Office of Facilities
	410 E. 21 STREET	SOLUTIONS 2520 RENAISSANCE BLVD.,	ENGINEERS	GROUP 7330 CHAPEL HILL ROAD,	2453 N DELAWARE STREET	7508 E. INDEPENDENCE		ENGINEERING 1823 DEEP RUN ROAD	1251 ROMANSVILLE ROAD	Mooney			Approved: Project Director	Location 1400 Black Ho	rse Hill, Coatesville, P	A Drawing Number	Management
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